

उत्तर प्रदेश मेट्रो रेल कॉरपोरेशन लि0 UTTAR PRADESH METRO RAIL CORPORATION LTD.

(Formerly Known as Lucknow Metro Rail Corporation Ltd.) (भारत सरकार एवं उत्तर प्रदेश सरकार का एक संयुक्त उपक्रम) (A JOINT VENTURE OF GOVT. OF INDIA & GOVT. OF U.P.)

No. UPMRC/CE-Contract/AGCC-05/2023-24

Date: 25.01.2024

ADDENDUM-04

Name of Work: Tender AGCC-05: Design and Construction of elevated viaduct and 3 Nos. elevated stations (viz. ISBT, Guru Ka Taal & Sikandara Metro Station) including Civil, Associated Ancillary Structure, Architectural Finishes, Water Supply, Sanitary Installation, Drainage, External Development, Fire Fighting, Fire Detection, E&M works and PEB structures on Balance Section chainage (-) 42.96 m to 3682.941 m of Corridor-1 of Agra Metro at Agra, Uttar Pradesh, India

General Arrangement Drawings (GAD) is being uploaded on CPP Portal. Also, link for downloading Auto CAD drawings of same is as under:

https://drive.google.com/file/d/1qcPsR7HkI9o4gN6s_apKAM1PtltGDHBm/view?usp=sh_aring

For any further modifications/changes (if any), bidders are advised to stay updated on e-tendering portal (<u>https://etenders.gov.in/eprocure/app</u>) for information please.


Sd--xx CE/Contract

)	END :	
Spiral	ar Curve	
TS SC CS ST SS CCL TRL/TI R L/CL SL G	= Tangent to Spiral = Spiral to Curve = Curve to Spiral = Spiral to Spiral = Spiral to Spiral = Circular Curve Length = Length of Spiral Curve (Transition Length) = Radius of Curve = Length of Curve = Straight Length = Grade in %	SRI = Slock Rai Joint ELEV = Roll Elevation CH = Consilone Horizontal Curve ULC = UP lea Horizontal Curve ULC = UP lea Horizontal Curve ULC = UP lea Horizontal Curve CLC = Center Inst Microsoftal CVC = Point of Ventical Interaction PVT = Point of Ventical Tongent D = Dignee of Curve DE = DEAD END

()


 $-\bigcirc$


. .

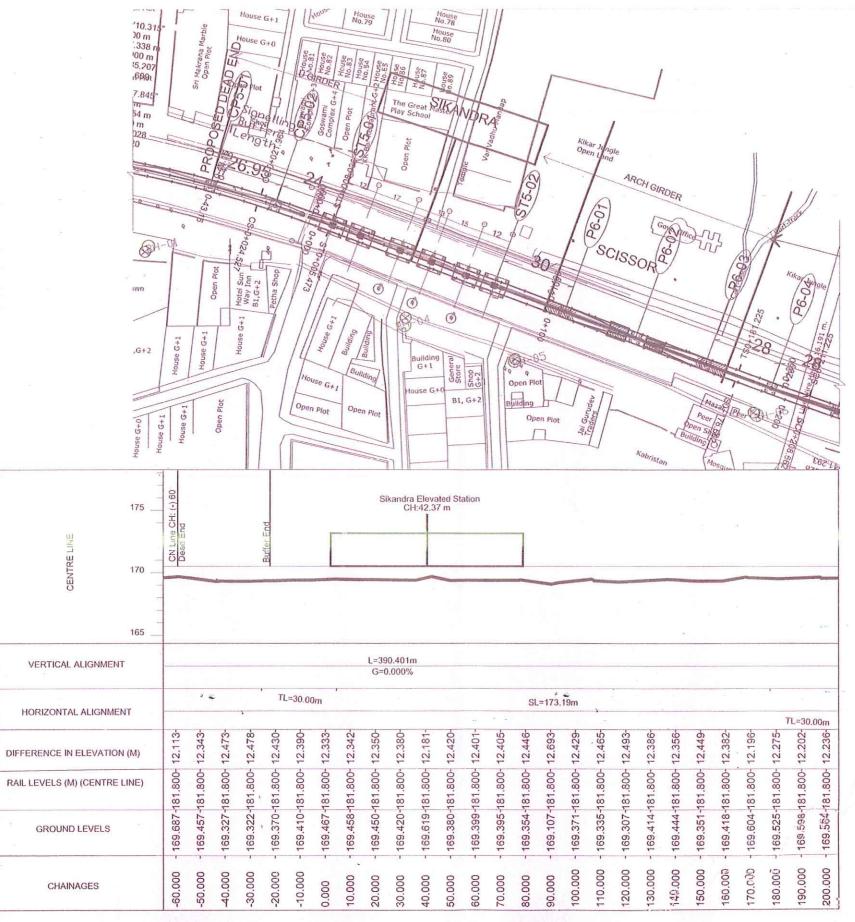

27.000.001	AL NOTES	NS ARE IN METERS UNLESS OTHERWISE	SPECIFIED.	INTEG	ESPONSIBIL RATION & FU RAWINGS R	ILL CO	MPLIAN	CE OF TH	HE CONT	RACT /	CODA	L PROV				LETENESS, SN, ANALYSI		HIS DRAWING, DESIGN S AND IS SUITABLE FO				ECKED BY	COUMER SIGNED B	DATE	SIQNATURE	PROJECT:
2. STAT	TIONS LOC	ATIONS MENTIONED HERE ARE ONLY IND	ICATIVE.	AND L	RAWINGS H	6919	with th	IE DE IA	LED DED	51014 60	UNSUL	IANT.						MOC		NOMC	-	RESUBMIT	UPMRCL	1.1.1	1	AGC
ARC	HITECTUR	AL DRAWINGS. AN LENGTH ARE INDICATIVE ONLY. EXACT		12							DDC			21/2			SIG	N: Aller	SIGN:	15th	SIGN:		DV OF IDEDITAL	al.1	1 me	UPMRCI
CON	TRACTOR	IN LENGTH SHALL BE PROPOSED BY THE DURING DETAILED DESIGN. IOWN HERE ARE INDICATIVE ONLY, ACTUA		P1	SIGN.		Ama a	Raje						Autoport A sare		23-01-202	DAT	E: 23.01.2024	DATE: NAME	23.01.2024 MSJ	DATE:	23.01.2824 BKJ	DY.CE /DESIGN	24.	2	CLIENT: UP METRO R
		INVERTICATIVE ONLY, ACTUA IALL BE AS PER DETAILED DESIGN BY CON	TRACTOR			1	Singh	evK	AR	EL	IC	ME		000 00 10 10 10 Des 201800 21	1	-		SIGNATION: SE		NATION: SSE	in the second	IATION: CSE	CE /DESIGN	24/01	or	LOCATION: BALANCE ELEVA
	T			ISSUE		DRN	DSN	CHD			CL	EARED		PE/PM	APP	D DATE		REVIEWED BY		APPROVED BY	2.2	VETTED BY			0.	
									DET	AIL DES	SIGN CO	ONSULT	TANT	16. 1				GENERAL CONSULTANT			rtium of T		DY.GE /CIVIL	0111	20	TITLE: TRACK ALIGNMENT GA
						9					Par	1	S. S.	al Mine	151	1		1			tos, S.A.	and	DIGERGIVIE	2511	0	
P1	23-01-2024	REVISED ALIGNMENT & PIER SETTING OUT				TAT					51		1. 201		lipl					Italfen		ALL AND ALL AND A		1 11	24	SCALE: 1:750 DATE: 2
P0	26-09-2023	ISSUED FOR TENDER PURPOSE		TA	TA CONSULT			LIMITED		311 P	ROGETI	TISDA		LEAP INFRAA	SYS PRIVA	ATE LIMITED		TYPSA - ITALFERR			Floor, Cyber H hano, Gomti N		CPM	1 23 0	Shink	DRG NO: AGCC05-11718A-T
REVNO	DATE	DESCRIPTION	SIGN		are controler,	N.J.M					FOVE IT				FARIDADAD	2		TT-3A TTALFER		Lucinow	-226010	Sec. Sec.		1 1	011	-

	Ŷ		
	,		1
		÷	
		(a. 11)	
/			
	8		
*			
	/		
	· *		
	5		
			74
			1
		OFFICE OF ORIGIN	
	RO RAIL CORPORATION LTD. PROJECT-CORRIDOR 1	T	
GCC-05: BALANCE ELEVATED	SECTION FROM SIKANDRA TO RAMP	TATA	
		<u>[31</u>]	2.4
RAIL CORPORATI	ON LTD.		
EVATED SECTION FROM SIKA	NDRA TO RBS RAMP	ک تا الآبار	
GAD (TOPO REFERENCE) S	HEET 01 OF 09		-
and the second		REVISION NO:	
E: 23-01-2024 STAGE: TD	R	1	1
A-TDR-AE5-CV-GAD-51820		P1	

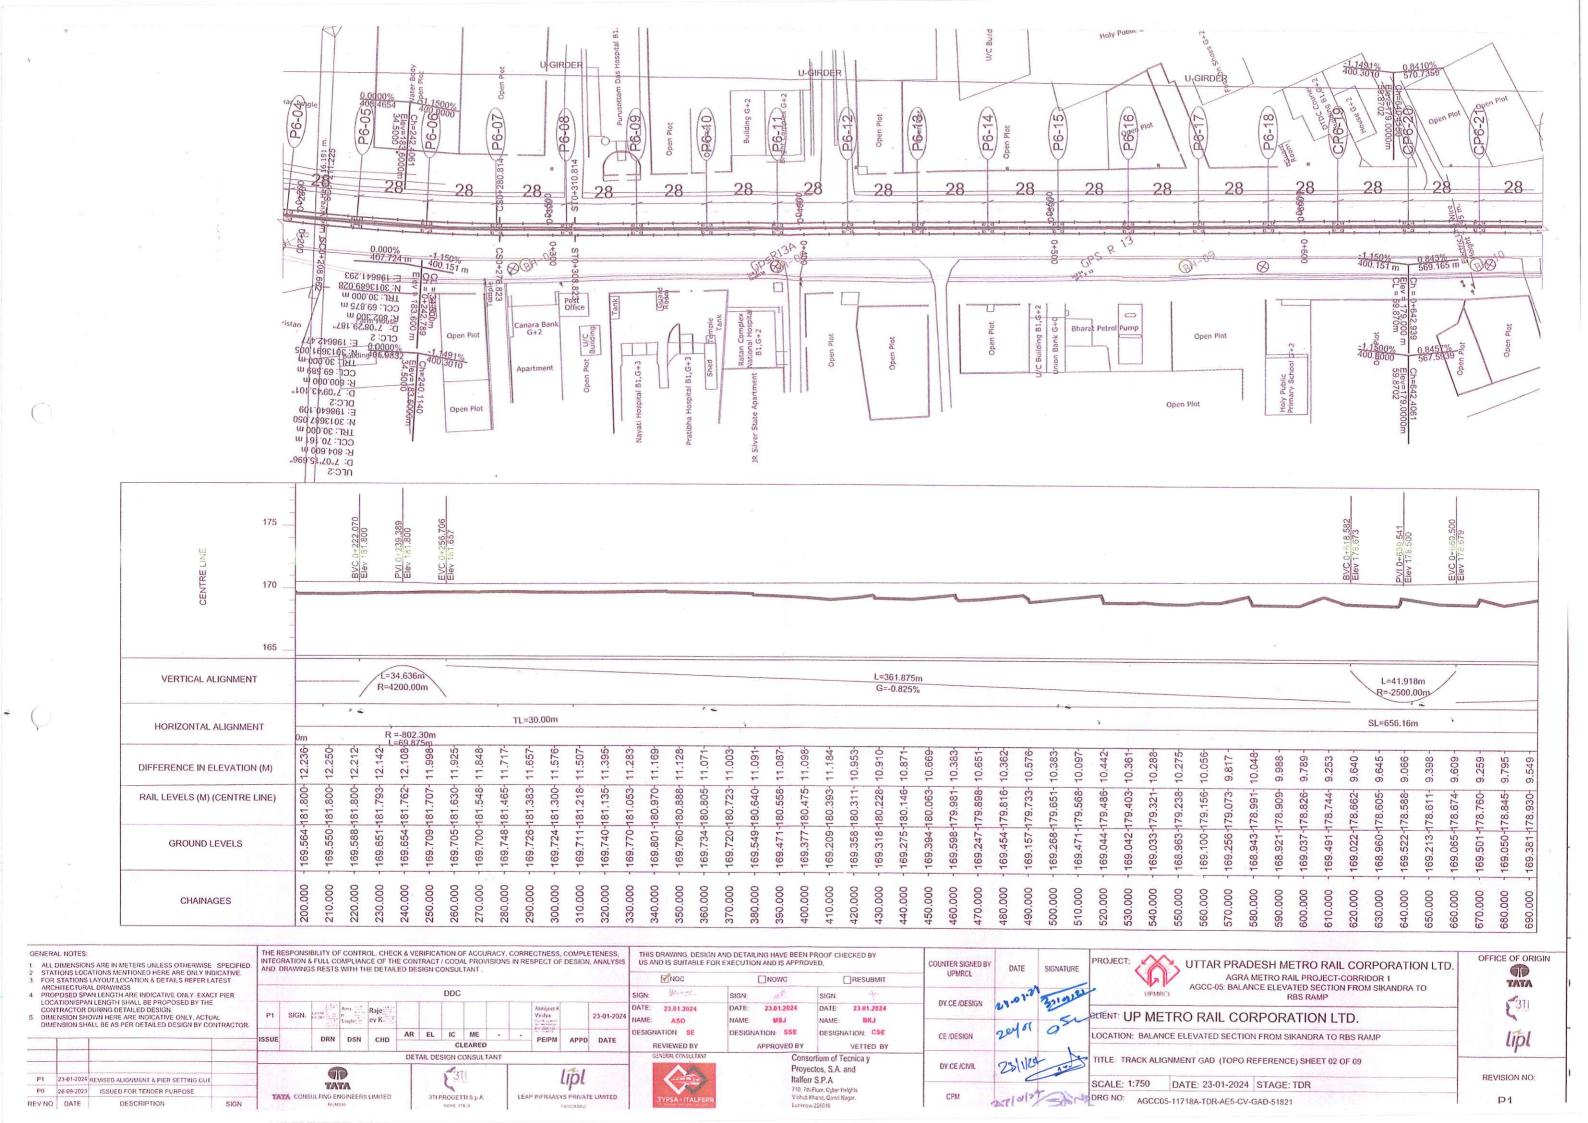

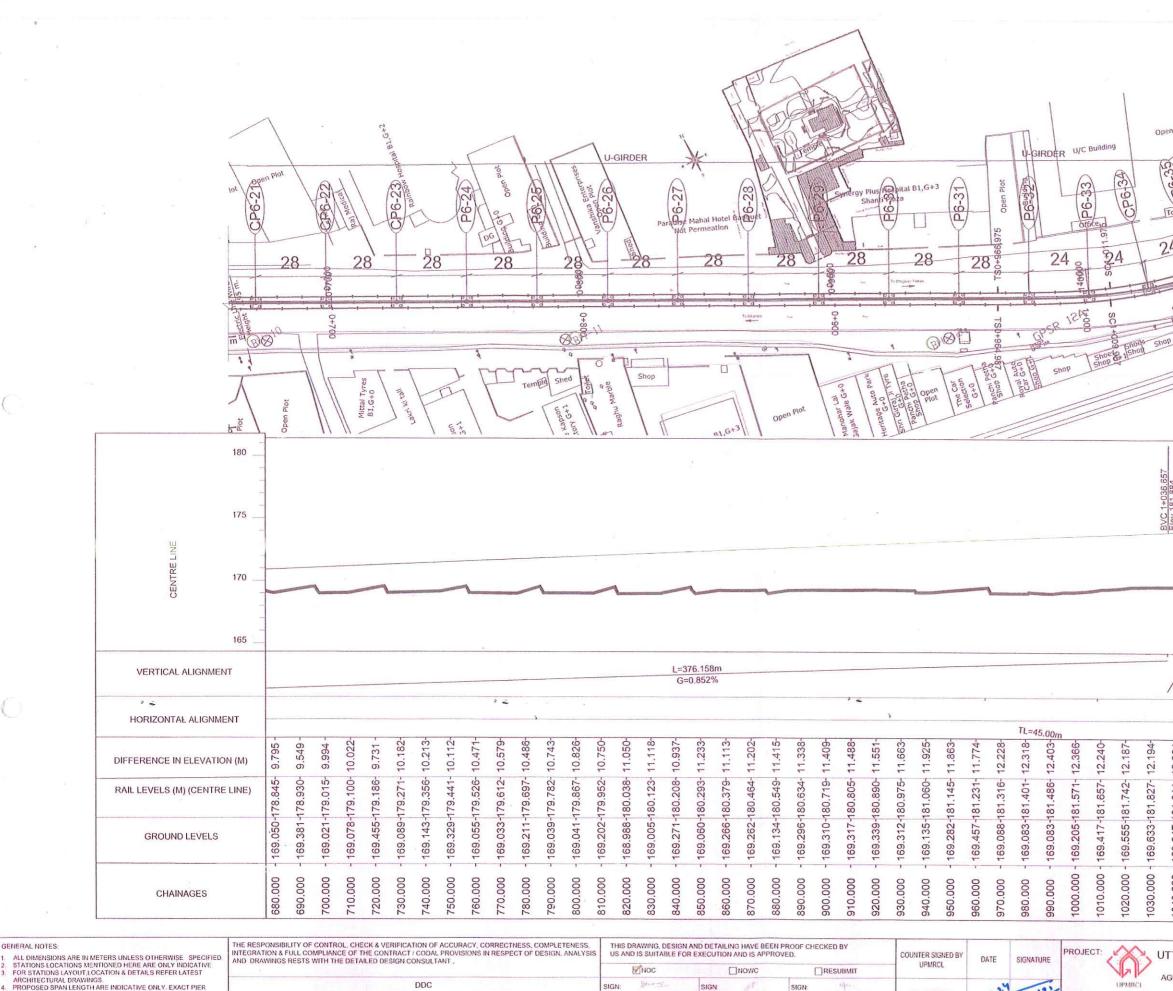

GERERAL ROTES:
GERERAL ROTES:
STATIONS LOCATIONS MENTIONED HÉRE ARE ONLY INDICATIVE.
STATIONS LOCATIONS MENTIONED HÉRE ARE ONLY INDICATIVE.
FOR STATIONS LAYOUT, LOCATION & DETAILS REFER LATEST ARCHITECTURAL DRAVINGS.
PROPOSED SPAN LENGTH ARE INDICATIVE ONLY. EXACT PIER LOCATIONSPAN LENGTH SHALL BE PROPOSED BY THE CONTRACTOR DURING DETAILED DESIGN.
DIMENSION SHOWIN HERE ARE INDICATIVE ONLY. ACTUAL DIMENSION SHALL BE AS PER DETAILED DESIGN BY CONTRACTOR DY.CE /DESIGN DATE: 23.01.2024 23.01.2024 Abhijeet I Vaidya 23.01.2024 DATE DATE Ama and a Singh Raje ev K P1 SIGN. 23-01-2024 NAME MSJ ASO BKJ NAME: NAME: DESIGNATION: SE DESIGNATION: SSE DESIGNATION: CSE AR EL IC ME CE /DESIGN DRN DSN CHD SUE PE/PM APPD DATE CLEARED REVIEWED BY APPROVED BY VETTED BY DETAIL DESIGN CONSULTANT FRAI CONSISTA Consortium of Tecnica y DY.CE /CIVIL Proyectos, S.A. and T 3TI lipl Italferr S.P.A P1 23-01-2024 REVISED ALIGNMENT & PIER SETTING OUT TATA 710. 7th Floor, Cyber Heights Vichuti Khand, Gond Nagar. Lucknow-226010

STI PROGETTI S.p.A

ROME ITALY

LEAP INFRAASYS PRIVATE UMITED

TATA CONSULTING ENGINEERS LIMITED

301121 4.01 CLIENT: UP METRO 01 201 0 LOCATION: BALANCE ELEV 25/1/20 TITLE: TRACK ALIGNMENT 0 SCALE: 1:750 DATE: 23/01/2 ORG NO: AGCC05-11718A-

CPM


REV NO DATE

P0 26-09-2023 ISSUED FOR TENDER PURPOSE


DESCRIPTION

SIGN


山田	495660 100569 100569 1000000000000000000000000000000000000	A Chorner Chorner	and a set of the set o	Service Book Enried Burker		OF THE REPORT OF	Sc. 3d 22				60.030	
Elev 181.884	PVI 1+050.290 Elev 182.000	EVC 1+063.924	0			3						
R=	27.266	m				1						
		-	3				TL	=45.0	0m			÷
64-	L=89.4	, <u>30m</u> 994	55-	17-	10-	18-	24-	92-	24-	29-	28-	- <i>T</i>
12.2	2=-197 L=89.4 Sc. 7	12.4	12.355-	12.017-	12.2	12.518	12.5.	12.492-	12.467	12.459-	12.558-	
	-016	-966	-000	-000	-000		-000	-000	-000			
5	181	-181	-182	-182.	-182.	-182.	-182.	-182.	-182.	-182.	-182.	
-181.9	1	.587	.645	.983	.782	1.482	.476	.508	.533	.541	.442	
1.647-181.9	.619-		5	169	- 169	- 169.482-182.000-	- 169	- 169	- 169	- 169	169	
- 169.647-181.9	- 169.619-	- 169	16			1000	0	00	8	000	000	
.000 - 169.647-181.9	.000 - 169.619-	.000 - 169	.000 - 16	- 000	000	000	00.	00	0	-	0	
1040.000 - 169.647-181.911- 12.264-	1050.000 - 169.619-181.970-	1060.000 - 169.587-181.998-	1070.000 - 169.645-182.000-	1080.000 - 169.983-182.000-	1090.000 - 169.782-182.000- 12.218-	1100.000	1110.000 - 169.476-182.000- 12.524	1120,000 - 169.508-182.000-	1130.000 - 169.533-182.000-	1140.000 - 169.541-182.000-	1150.000 - 169.442-182.000-	
TAI SCC-		ADES A MET ANCE	SH ME RO RA ELEVA R	ETRO IIL PRO ITED SI IBS RA	D RAII	L COI CORRI N FROI	RPOF DOR 1 M SIKA	RATIC	ON LT	T		
TAI SCC-	R PRA AGR 05: BAL IL C(ADES A MET ANCE ORP	SH ME RO RA ELEVA R OR/	ETRO IIL PRO ITED SI IBS RA ATIO KANDE	O RAII	COR CORRIN N FROM	RPOF DOR 1 M SIKA	RATIC	ON LT	T		TATA
TAI SCC- RA ATEL		ADES A MET ANCE ORP ION FF	SH ME RO RA ELEVA R OR/	ETRO IIL PRO ITED SI BS RA ATIO KANDF E) SHE	O RAII	COR CORRIN N FROM	RPOF DOR 1 M SIKA	RATIC	ON LT	T	OFF	

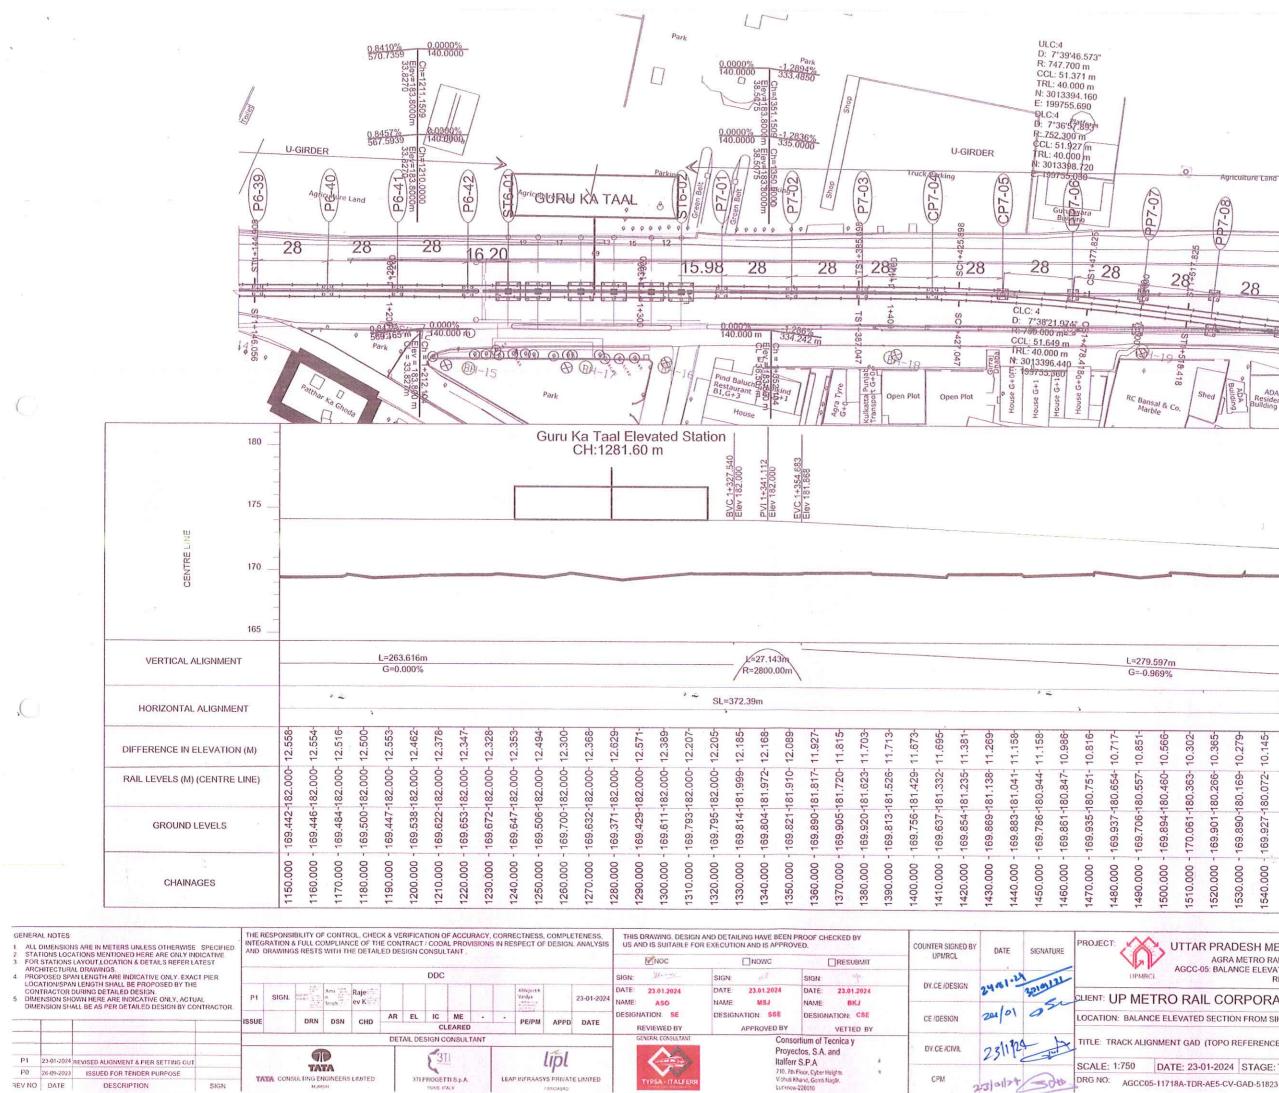

mar Ujala G+1 90 0 28 28 28 28 (CAR) ADA Shed B 730 TL=80.00m 10.302 145 10.043 9.713 9.342 9.825 9.545 9.485 968 888 0 0 o 490-169.908-179.393-169.954-179.296-781 5 -179. 8 00 79. 79. 2 169.910 893 69.874 945 859 70.061 700 80 69 69 69 69. 69 69 69 1580.000 1600.000 1610.000 1510.000 1560.000 1570.000 590.000 000 530.000 540.000 000 1620.000 550.0 520. OFFICE OF ORIGIN UTTAR PRADESH METRO RAIL CORPORATION LTD. T AGRA METRO RAIL PROJECT-CORRIDOR 1 AGCC-05: BALANCE ELEVATED SECTION FROM SIKANDRA TO TATA RBS RAMP 311 CLIENT: UP METRO RAIL CORPORATION LTD. LOCATION: BALANCE ELEVATED SECTION FROM SIKANDRA TO RBS RAMP lipl ITLE: TRACK ALIGNMENT GAD (TOPO REFERENCE) SHEET 04 OF 09 REVISION NO: DATE: 23-01-2024 STAGE: TDR P1

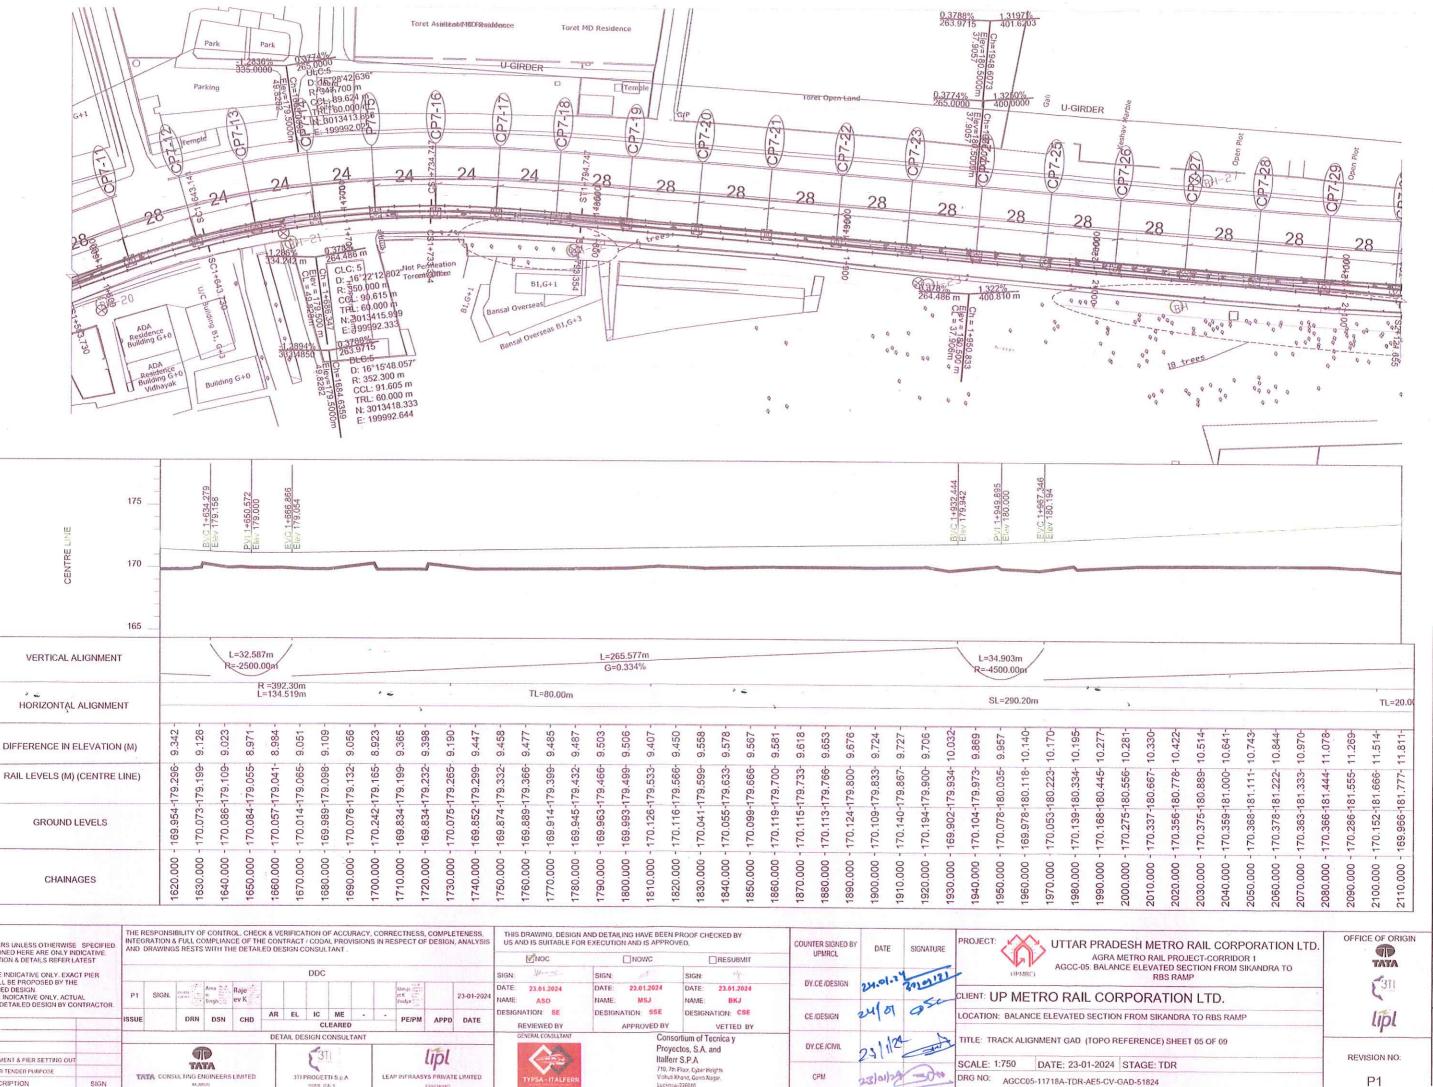



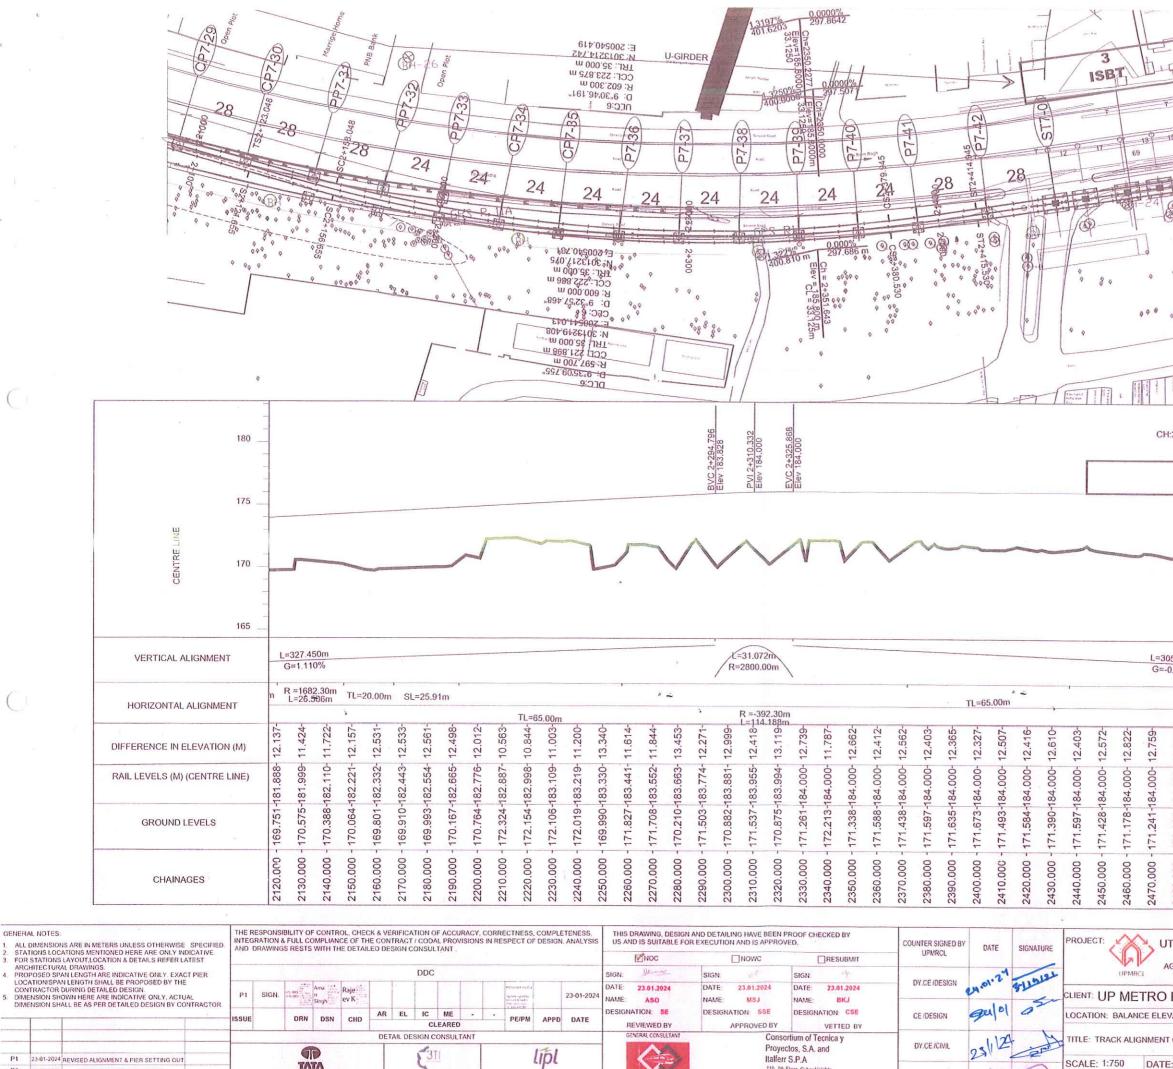

P0 26-09-2023 ISSUED FOR TENDER PURPOSE SIGN REV NO DATE DESCRIPTION

TATA CONSULTING ENGINEERS LIMITED LEAP INFRAASYS PRIVATE LIMITED 311 PROGETTI S.p.A. PONE ITAL


MANAL

710, 7th Floor, Cyber Heights Vichuti Khand, Gomti Nagar Lucknow-226010


CPM

SCALE: 1:750 23/01 DRG NO: AGCC05-11718A

	12) () () () ()	CUERC	0	•	A EUTRO 1 000002201 2+600			
ISB1 2483	Г .27 m							1	5	3			
		~	~						_				
5.916								· ~				3	
2480.000 - 170.925-184.000- 13.075-	2490.000 - 171.235-184.000- 12.765-	2500.000 - 170.982-184.000- 13.018-	2510.000 - 170.964-184.000- 13.036-	2520.000 - 171.000-184.000- 13.000-	2530.000 - 171.266-184.000- 12.734-	2540.000 - 171.754-184.000- 12.246-	2550.000 - 172.003-184.000- 11.997-	2560.000 - 171.701-184.000- 12.299-	2570.000 - 171.492-184.000- 12.508-	2580.000 - 171.331-184.000- 12.669-	2590.000 - 171.012-184.000- 12.988-	2600.000 - 170.970-184.000- 13.030-	а 1
GCC-(AGI 05: BAI		FRO RA	AIL PRO ATED S RBS RA	DJECT- ECTIO	CORR N FRO	IDOR 1			D.	OF	T	F ORIGIN
ATEC	SECT	ORF	ROM SI	KAND	RATO	RBS R	AMP						ρl
: 23-(01-20	24 ST	TAGE:	TDR	ET 06	OF 09					RE	EVISION P1	NO:

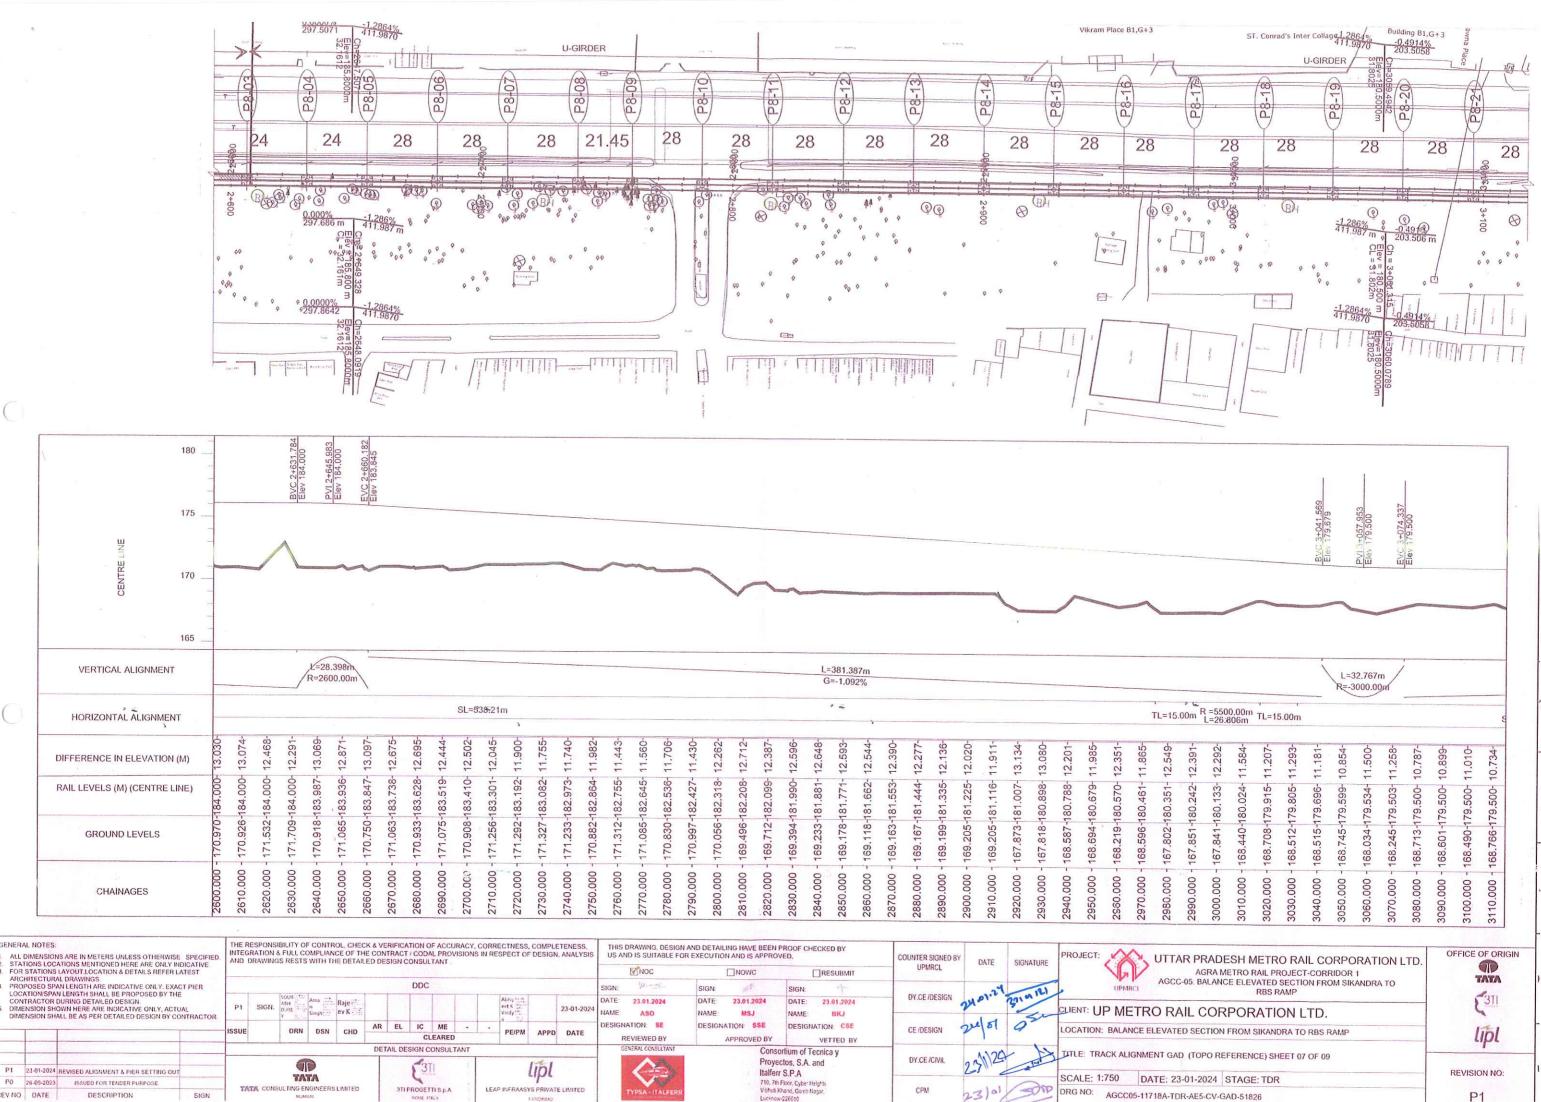


	AL NOTES:	IS ARE IN METERS UNLESS OTHERWISE		INTEGRAT	ION & FULL	COMPLIA	NCE OF TH	HE CONTR	ACT / CO	DAL PR	ROVISIO	Y, COR	RECTNE	SS, COMP	LETENESS,	S US	IS DRAWING, DESIGN AND IS SUITABLE FOR	ND DETAI	LING HAVE BEEN	PROOF CH	ECKED BY	COUNTER SIGNED BY			PROJECT:
2. STA 3. FOR	TIONS LOCA	ATIONS MENTIONED HERE ARE ONLY IN LAYOUT, LOCATION & DETAILS REFER L	DICATIVE	AND DRA	WINGS RES	STS WITH	THE DETAI	LED DESI	GN CONSI	ULTAN	r.						NOC			1	RESUBMIT	UPMRCL	DATE	SIGNATURE	$\langle \Omega \rangle^{0}$
4 PR(POSED SP/	AL DRAWINGS. AN LENGTH ARE INDICATIVE ONLY, EXAC N LENGTH SHALL BE PROPOSED BY THE							DD	С						SIGN:	: <u></u>	SIGN:	Nº F	SIGN	- 4 + <u>1</u> +		24	12)	UPMRCI
CO	TRACTOR	DURING DETAILED DESIGN. DWN HERE ARE INDICATIVE ONLY, ACTU		P1 S	IGN. DJBE	Ama II n	Raje ev K						Abhij **		23-01-202	4 DATE		DATE	23.01.2024	DATE:	23.01.2024	DY.CE /DESIGN	24.01.	331.4	CLIENT: UP METRO F
DIM	ENSION SH	ALL BE AS PER DETAILED DESIGN BY CO	INTRACTOR.		γ :	Singh.		AR	EL IC	ME	E .		A II	1	-		E ASO GNATION: SE	NAME: DESIGN	MSJ NATION: SSE	NAME: DESIGN	BKJ	05 (050)00	relot	050	
				ISSUE	DR	IN DSN	CHD			CLEAR			PE/P	M APP	D DATE		REVIEWED BY		APPROVED BY		VETTED BY	CE /DESIGN	-1.	-	LOCATION: BALANCE ELEVA
-	-							DETA	L DESIGN	CONSI	ULTANT				0		GENERAL CONSULTANT		Conso	ortium of T	ecnica y		1125	L by	TITLE: TRACK ALIGNMENT O
P1	23-01-2024	REVISED ALIGNMENT & PIER SETTING OUT			1				5	3TI				lipl						ctos, S.A. S.P.A	and	DY.CE /CIVIL	23	H	00415 4750
PO	26-09-2023	ISSUED FOR TENDER PURPOSE		TATE	CONSULTING	ATA	RELANTER		3TI FROG	CTUC.			ID BUCDA	1	TELIMITED					Floor, Cyber H		CPM		200	SCALE: 1:750 DATE:
REV NO	DATE	DESCRIPTION	SIGN	anter		UJUBAI	NO LIMITED			TAX	A	LE	AP INFROM	135704ULY			TYPSA - ITALFERR			Chand, Gord N	lagar,	CPM	23/01	Som	DRG NO: AGCC05-11718A-

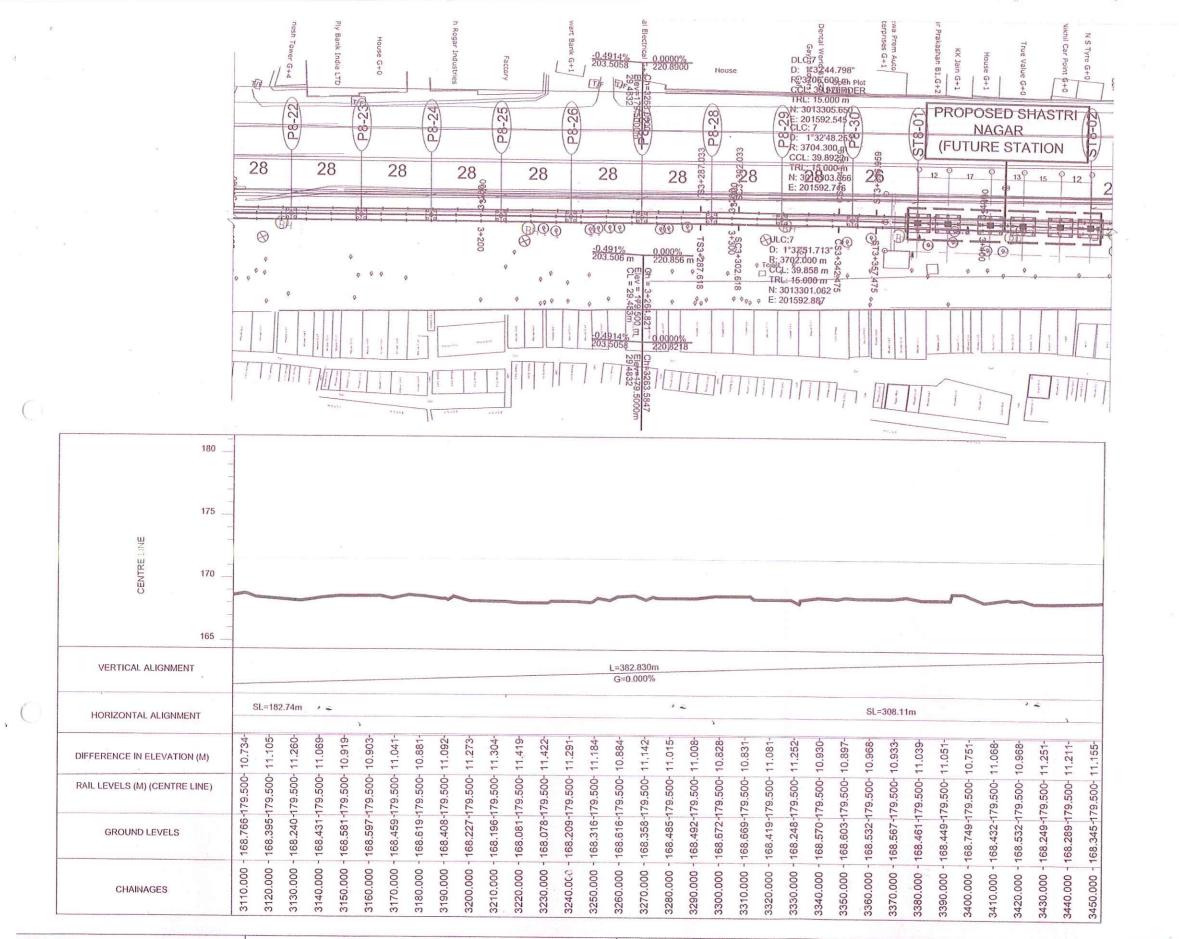



2						•
						a (
		- b				
				9		
				÷.		
	1					
	943	· ~				1
			\$			
			. ÷			-
						F
1 A						° ∦
						•
×						1
						-
		DODAT		OFFICE	OF ORIGIN	
AR PRADESH METE AGRA METRO RAIL P	ROJECT-CORRI	OR 1			T	
C-05: BALANCE ELEVATED	SECTION FROM	SIKANDRA	то	4	TATA	}
	RAMP	-	-	1	311	
AIL CORPORATI	ION LTD.					
ED SECTION FROM SIKAN	IDRA TO RBS RA	MP			lipl	Γ
					ipi	1
	HEET 08 OF 09		F			-
AD (TOPO REFERENCE) SI				REVISI	ON NO:	1
AD (TOPO REFERENCE) SI 3-01-2024 STAGE: TDI DR-AE5-CV-GAD-51827					on no: 21	1

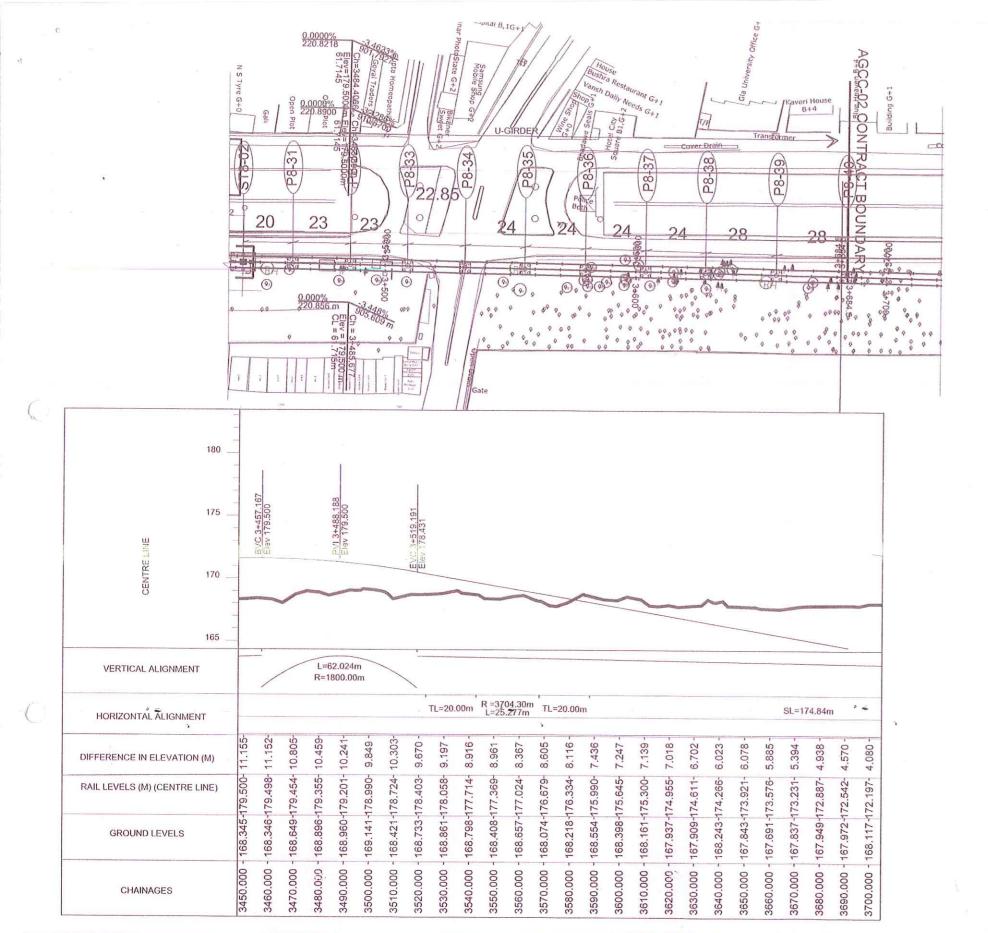



				÷.	
		(A.)			
			-		ļ
				3	1
•					•
3					
2					а - С
8					
					8
	3	2			
	i.				
		2			-
				OFFICE OF OF	RIGIN
	METRO RAIL C		ON LTD.		
05: BALANCE ELE	EVATED SECTION F RBS RAMP	ROM SIKANDRA	TO		ł
	Chr. Sector Chr. Chr. Chr. Chr. Chr. Chr. Chr. Chr			C3TI	
	RATIONLIL				F
IL CORPO				lipl	
IL CORPO	I SIKANDRA TO RBS	S RAMP		cipic	
IL CORPO				cipe	
IL CORPO	M SIKANDRA TO RBS			REVISION NO	